
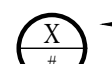















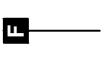





HVAC PLAN SYMBOL LEGEND


-  EQUIPMENT TYPE (REFER TO EQUIPMENT SCHEDULE)
-  EQUIPMENT REFERENCE NUMBER
-  DIFFUSER/GRILLE TYPE (REFER TO SCHEDULE)
-  CUBIC FEET PER MINUTE (CFM) / FACE SIZE
-  SUPPLY DUCTWORK
-  RETURN DUCTWORK
-  EXHAUST DUCTWORK
-  OUTSIDE AIR DUCTWORK
-  FLEX DUCT
-  VENT / COMBUSTION AIR
-  CONDENSATION LINE
-  REFRIGERANT LINE
-  TIE INTO EXISTING
-  SUPPLY DIFFUSER (HATCH INDICATES "NO FLOW ZONE")
-  RETURN DIFFUSER
-  BALANCE DAMPER
-  MOTORIZED DAMPER
-  CEILING RADIATION DAMPER
-  FIRE RATED DAMPER
-  SMOKE DAMPER
-  THERMOSTAT


HVAC PLAN GENERAL NOTES:


1. SEE SHEET M501 FOR ADDITIONAL HVAC NOTES, DETAIL, AND SCHEDULES.

HVAC PLAN KEY NOTES:


- ① 4" FLUE UP THRU ROOF.
- ② 4" COMBUSTION AIR INTAKE UP THRU ROOF.

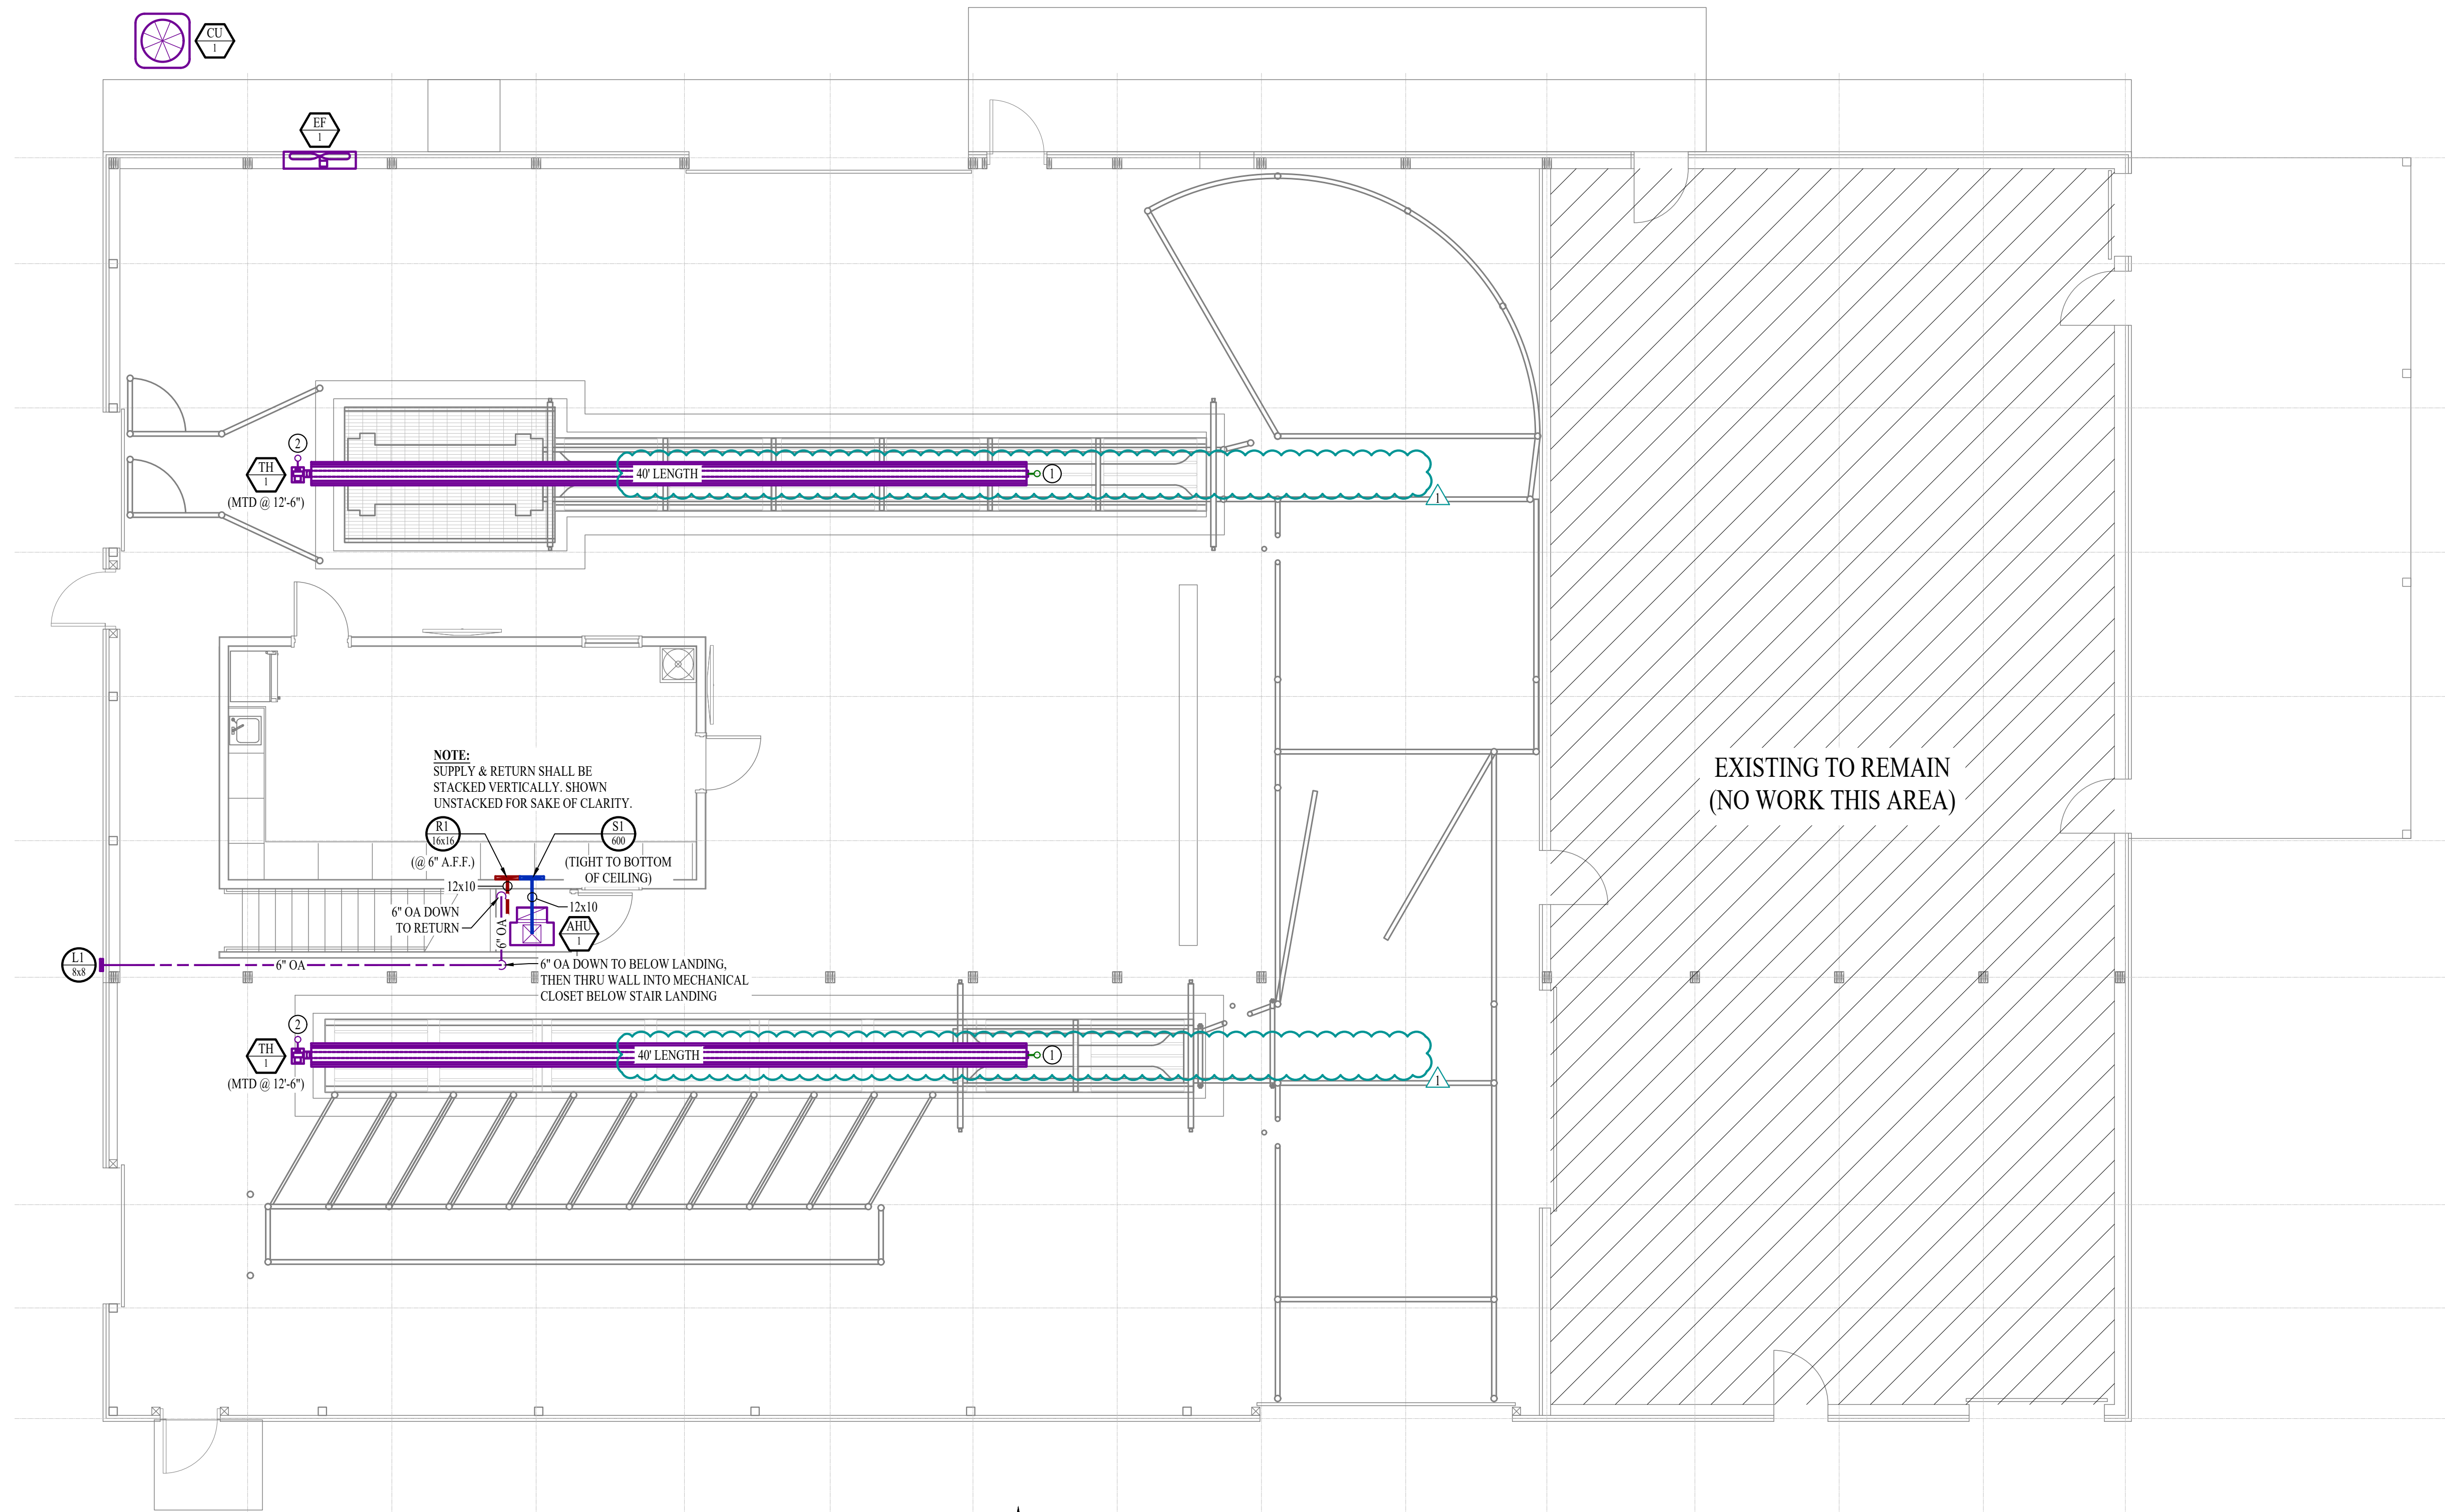


HVAC PLAN
 SCALE: 3/16" = 1'-0"

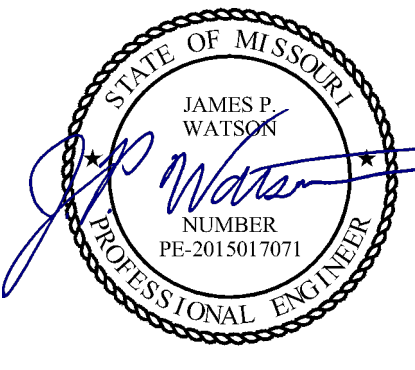

James Watson, P.E. March 26, 2024
 PE-2015017071
 MO Certificate of Authority # 2018029680

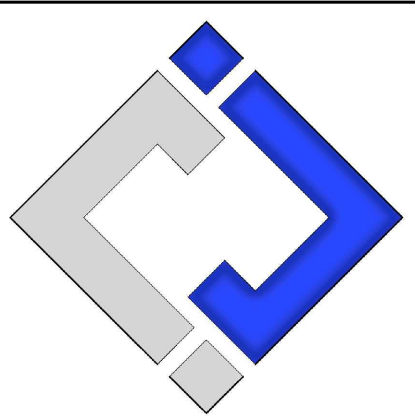

**J-SQUARED
ENGINEERING**

2400 Bluff Creek Drive, Suite 101
 Columbia, Missouri 65201
 573 - 234 - 4492 phone
 www.j-squaredeng.com

J2 PROJECT No:	J21143
J2 DESIGN:	JAP

ISSUE TITLE	DATE
DD SET	01 - 19 - 2024
100% CD	02 - 09 - 2024
BID SET	03 - 01 - 2024
ADDENDUM #1	03 - 26 - 2024

Mechanical - Electrical - Plumbing Design Drawings for
CP241191 South Farm Creed Barn Remodel
 5151 Old Millers Road
 Columbia, Boone County, MO 65201

AHJ APPROVAL STAMP

SHEET TITLE

HVAC PLAN

SHEET NUMBER

M101

HVAC SPECIFICATIONS

1. EQUIPMENT
 - 1.1. ALL EQUIPMENT MUST PROVIDE THE PERFORMANCE SPECIFIED ON PLANS. WHERE SPECIFIC MAKES & MODELS ARE INDICATED ON PLAN, CONTRACTOR TO PROVIDE MODEL INDICATED OR APPROVED EQUAL.
 - 1.2. CONTRACTOR TO SUPPLY SUBMITTALS FOR ALL EQUIPMENT FOR REVIEW BY ARCHITECT & ENGINEER PRIOR TO PURCHASE.
 - 1.3. REFRIGERANT PIPING TO BE ACR COPPER.
2. DUCTWORK
 - 2.1. DUCTWORK TO BE GALVANIZED STEEL, SEAL CLASS B, CONSTRUCTED PER SMACNA STANDARDS.
 - 2.2. 26 GA. MINIMUM UP TO 16" DUCT, 24 GA. UP TO 20", 22 GA. UP TO 24", 20 GA. UP TO 28", AND 18 GA. UP TO 36".
 - 2.3. DOUBLE WALL TURNING VANES TO BE PROVIDED & INSTALLED AT ALL 90° BENDS & TEES.
 - 2.4. DUCT DIMENSIONS LISTED ARE TO INTERIOR OF DUCT.
 - 2.5. BALANCE DAMPERS MUST BE PROVIDED TO ALLOW ADJUSTMENTS AT EACH AIR TERMINAL.
 - 2.5.1. WHERE BRANCH TAKEOFF IS ACCESSIBLE (ABOVE LAY-IN CEILING OR EXPOSED DUCT), THE BALANCE DAMPER IS TO BE INSTALLED AT TAKEOFF.
 - 2.5.2. WHERE BRANCH TAKEOFF IS INACCESSIBLE (IN ATTIC OR SOFFIT), THE BALANCE DAMPER IS TO BE LOCATED SO IT IS ACCESSIBLE FROM FACE OF AIR DEVICE.
 - 2.6. HVAC CONTRACTOR RESPONSIBLE FOR ALL DUCTWORK TRANSITIONS & FITTINGS AS REQUIRED FOR FINAL CONNECTIONS TO HVAC EQUIPMENT.
3. INSULATION
 - 3.1. DUCTWORK
 - 3.1.1. EXTERNAL DUCT WRAP TO INCLUDE VAPOR BARRIER EQUAL TO JOHNS MANVILLE MICROLITE FSK TYPE 100 (2" THICK).
4. WORKMANSHIP
 - 4.1. COORDINATE WITH OTHER TRADES SO THAT HVAC EQUIPMENT & DUCTWORK DOES NOT BLOCK REQUIRED ACCESS OR CLEARANCE TO OTHER EQUIPMENT.
 - 4.2. ALL HVAC EQUIPMENT IS TO BE INSTALLED PER MANUFACTURER'S PUBLISHED RECOMMENDATIONS.
 - 4.2.1. ALL EQUIPMENT TO BE INSTALLED LEVEL & PLUMB.

HEATER SCHEDULE											
TAG	EQUIPMENT TYPE	MANUFACTURER (OR EQUAL)	MODEL (OR EQUAL)	HEATING CAPACITY			PHYSICAL			NOTES	
				LOW (KBTU)	HIGH (KBTU)	VOLT/PH	MCA	OCF	DIML		WEIGHT
TH-1	RADIANT TUBE	REZNOR	VPT-N-80-A	60	80	120/1	7.5	20-1	60	112	1

NOTES:
1. 40" LONG WITH TWO-STAGE THERMOSTAT, COMBUSTION AIR INLET KIT, & THRU-ROOF VENT KIT

AHU & AC SCHEDULE													
TAG	EQUIPMENT DESCRIPTION	SIZE (TONS)	ORIENTATION	TOTAL AIRFLOW (CFM)	OA AIRFLOW MAX/MIN (CFM)	HEATING ELECTRIC (KW)	COOLING (IA: 80 DB/67 WB, OA: 95 DB)			ELECTRICAL			NOTES
							SENSIBLE (KBTU)	TOTAL (KBTU)	MIN EFF. (SEER)	VOLTS/PH	MCA	OCF	
AHU-1	AIR HANDLER	1.5	VERTICAL	600	-	3	-	-	-	240/1	24	25-2	1,2
CU-1	CONDENSING UNIT	1.5	-	-	-	-	13.2	17.8	13	240/1	12	20-2	5


NOTES:
1. PROVIDE AND INSTALL 7 DAY PROGRAMABLE HONEYWELL THERMOSTAT. COORDINATE EXACT MOUNTING LOCATION WITH OWNER.
2. INCLUDE CORROSION RESISTANT DRAIN PAN WITH OVERFLOW SWITCH WIRED TO SHUT DOWN UNIT.
3. WITH CO2 SENSOR AND MOTORIZED DAMPER
4. WITH LOW LEAKAGE MOTORIZED OUTSIDE AIR DAMPER, DAMPER TO OPEN DURING OCCUPIED HOURS AND CLOSE DURING UNOCCUPIED HOURS THRU THERMOSTAT SCHEDULE.
5. WITH FACTORY HAIL GUARD
6. LOW AMBIENT PACKAGE FOR OPERATION TO 0° F.

EXHAUST FAN SCHEDULE											
TAG	EQUIPMENT TYPE	MANUFACTURER (OR EQUAL)	MODEL (OR EQUAL)	FLOW		ELECTRICAL			PHYSICAL		NOTES
				CFM	S.P.	VOLT/PH	MCA	OCF	DIML	WEIGHT	
EF-1	SIDEWALL FAN	S & P	LC48-2-E	17610	.375"	240/1	12	20-2	54 x 54	500	1,2,3


NOTES:
1. WITH GRAVITY DAMPER, RAIN HOOD, WALL HOUSING, & MOTOR GUARD
2. FAN TO BE MOUNTED FLUSH TO EXTERIOR
3. WITH 2 HP MOTOR

AIR DEVICE SCHEDULE						
TAG	SERVICE	MANUFACTURER (OR EQUAL)	MODEL (OR EQUAL)	SIZE	COLOR / FINISH	NOTES
S1	SUPPLY	PRICE	520	16x14	WHITE	SEE PLANS FOR AIRFLOW
R1	RETURN	PRICE	530	AS INDICATED	WHITE	
L1	OA / EX	PRICE	EFD-445	AS INDICATED	SEE NOTES	PAINT TO MATCH BUILDING


NOTES:
1. VERIFY AIR DEVICE FINISHES WITH OWNER/ARCHITECT PRIOR TO INSTALLATION

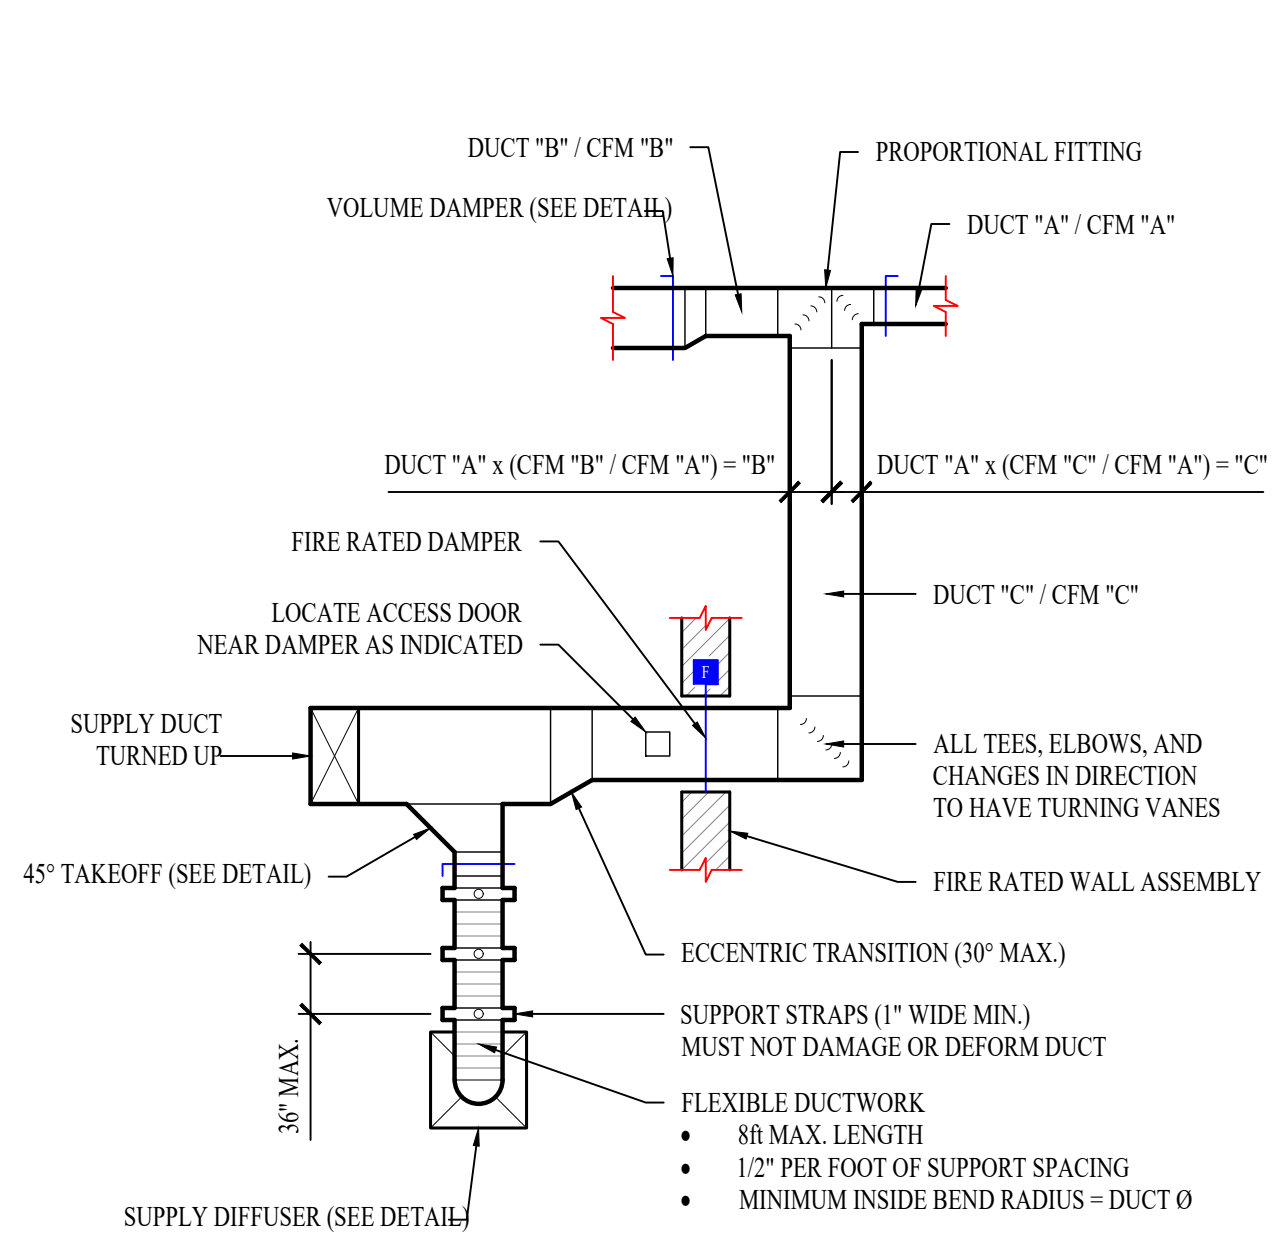


TYPICAL DUCTWORK DETAIL

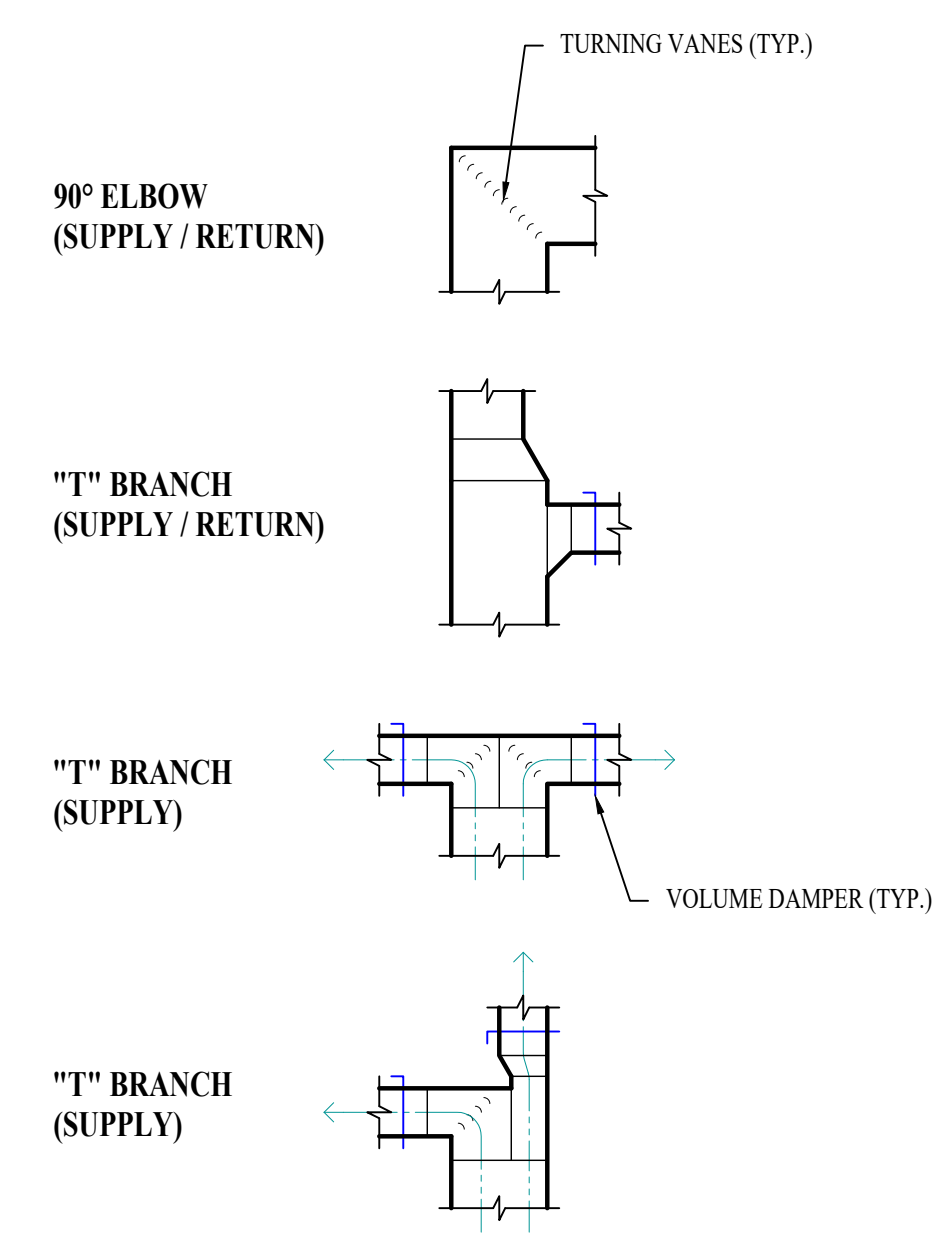

TYPICAL DUCTWORK FITTINGS DETAIL

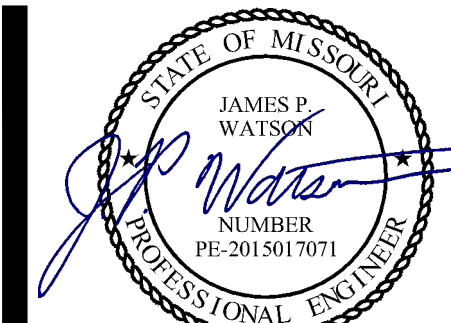

James Watson, P.E. March 26, 2024
PE-2015017071
MO Certificate of Authority # 2018029680

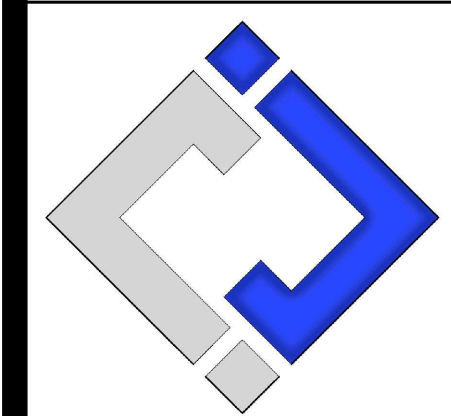

J-SQUARED ENGINEERING
2400 Bluff Creek Drive, Suite 101
Columbia, Missouri 65201
573 - 234 - 4492 phone
www.j-squaredeng.com

J2 PROJECT No: J21143
J2 DESIGN: JAP

ISSUE TITLE	DATE
DD SET	01 - 19 - 2024
100% CD	02 - 09 - 2024
BID SET	03 - 01 - 2024
ADDENDUM #1	03 - 26 - 2024

Mechanical - Electrical - Plumbing Design Drawings for
CP241191 South Farm Creed Barn Remodel
 5151 Old Millers Road
 Columbia, Boone County, MO 65201

AHU APPROVAL STAMP

SHEET TITLE

HVAC DETAILS & SCHEDULES

SHEET NUMBER


M501

ELECTRICAL SPECIFICATIONS

1. GENERAL
 - 1.1. THE ENTIRE ELECTRICAL SYSTEM SHALL BE CONTINUOUSLY GROUNDED. EVERY BRANCH CONDUIT SHALL INCLUDE A GREEN GROUND CONDUCTOR SIZED PER NEC.
 - 1.2. PROVIDE UPDATED TYPEWRITTEN PANEL SCHEDULE FOR EACH PANEL.
 - 1.3. ALL WIRING MUST BE DONE IN ACCORDANCE WITH MU PLANNING, DESIGN & CONSTRUCTION GUIDELINES.
2. MATERIALS
 - 2.1. CONDUIT & CONDUCTORS
 - 2.1.1. ALL CONDUCTORS SIZES INDICATED ON PLANS ARE COPPER UNLESS NOTED OTHERWISE.
 - 2.1.2. ABOVE GRADE CONDUCTORS SHALL BE THIN COPPER.
 - 2.1.3. MINIMUM CONDUCTOR SIZE SHALL BE #12 UNLESS NOTED OTHERWISE. 120V, 20 AMP CIRCUITS WITH CONDUCTOR LENGTH GREATER THAN 100' SHALL BE MINIMUM #10. ELECTRICAL CONTRACTOR IS RESPONSIBLE FOR MEASURING ACTUAL CONDUCTOR LENGTH AND INCREASING CONDUCTOR SIZE TO COMPENSATE FOR VOLTAGE DROP AS REQUIRED BY NEC.
 - 2.1.4. ALL WIRING SHALL BE RUN IN MINIMUM 3/4" EMT CONDUIT. CONTRACTOR MAY USE MC FOR LIGHTING WHIPS THAT ARE 5' OR LESS.
 - 2.1.5. DATA JUNCTION BOXES MAY NOT BE DAISY CHAINED.
 - 2.1.6. CONDUIT FOR DATA SHALL BE MINIMUM 1/2" EMT.
 - 2.2. DEVICES
 - 2.2.1. CONTRACTOR TO PROVIDE J-BOXES, COVER PLATES, AND ANY ACCESSORIES REQUIRED TO PROVIDE A COMPLETE SYSTEM. SEE ARCHITECTURAL PLANS FOR DEVICE COLORS. DUPLEX RECEPTACLES SHALL BE COMMERCIAL GRADE, 20 AMP.

LIGHT FIXTURE SCHEDULE										
TAG	MANUFACTURER (OR EQUAL)	MODEL NUMBER (OR EQUAL)	DESCRIPTION	MOUNTING	LUMEN OUTPUT	CCT (°K)	CRI	VOLTS	WATTS	NOTES
H1	METALUX	VHB-1215-W-UNV-L850-CD-U-LEVEL1	LED HIGH BAY	CHAIN	12579	5000	80	120	80	MOUNTED AT 17 A.F.F.
S1	METALUX	4SNX-74HL-UNV-L855-CD1	# LED STRIPLIGHT	CEILING	8391	3500	80	120	52	WITH SNX-LENS-LC-IFT-U & DECOEND-RND PK
X1	SURE LITES	UX7-I-SD	INTERIOR EXIT LIGHT	CEILING	-	-	-	120	1	WITH RED LETTERS
X2	SURE LITES	SELDW-TA 50SD	EMERGENCY EGRESS LIGHT	WALL	-	-	-	120	1	
X3	SURE LITES	APCH7R	INTERIOR EXIT LIGHT WITH HEADS	WALL / CEILING	-	-	-	120	1	WITH RED LETTERS

NOTES:
1. VERIFY LIGHT FIXTURE FINISHES WITH OWNER / ARCHITECT PRIOR TO INSTALLATION

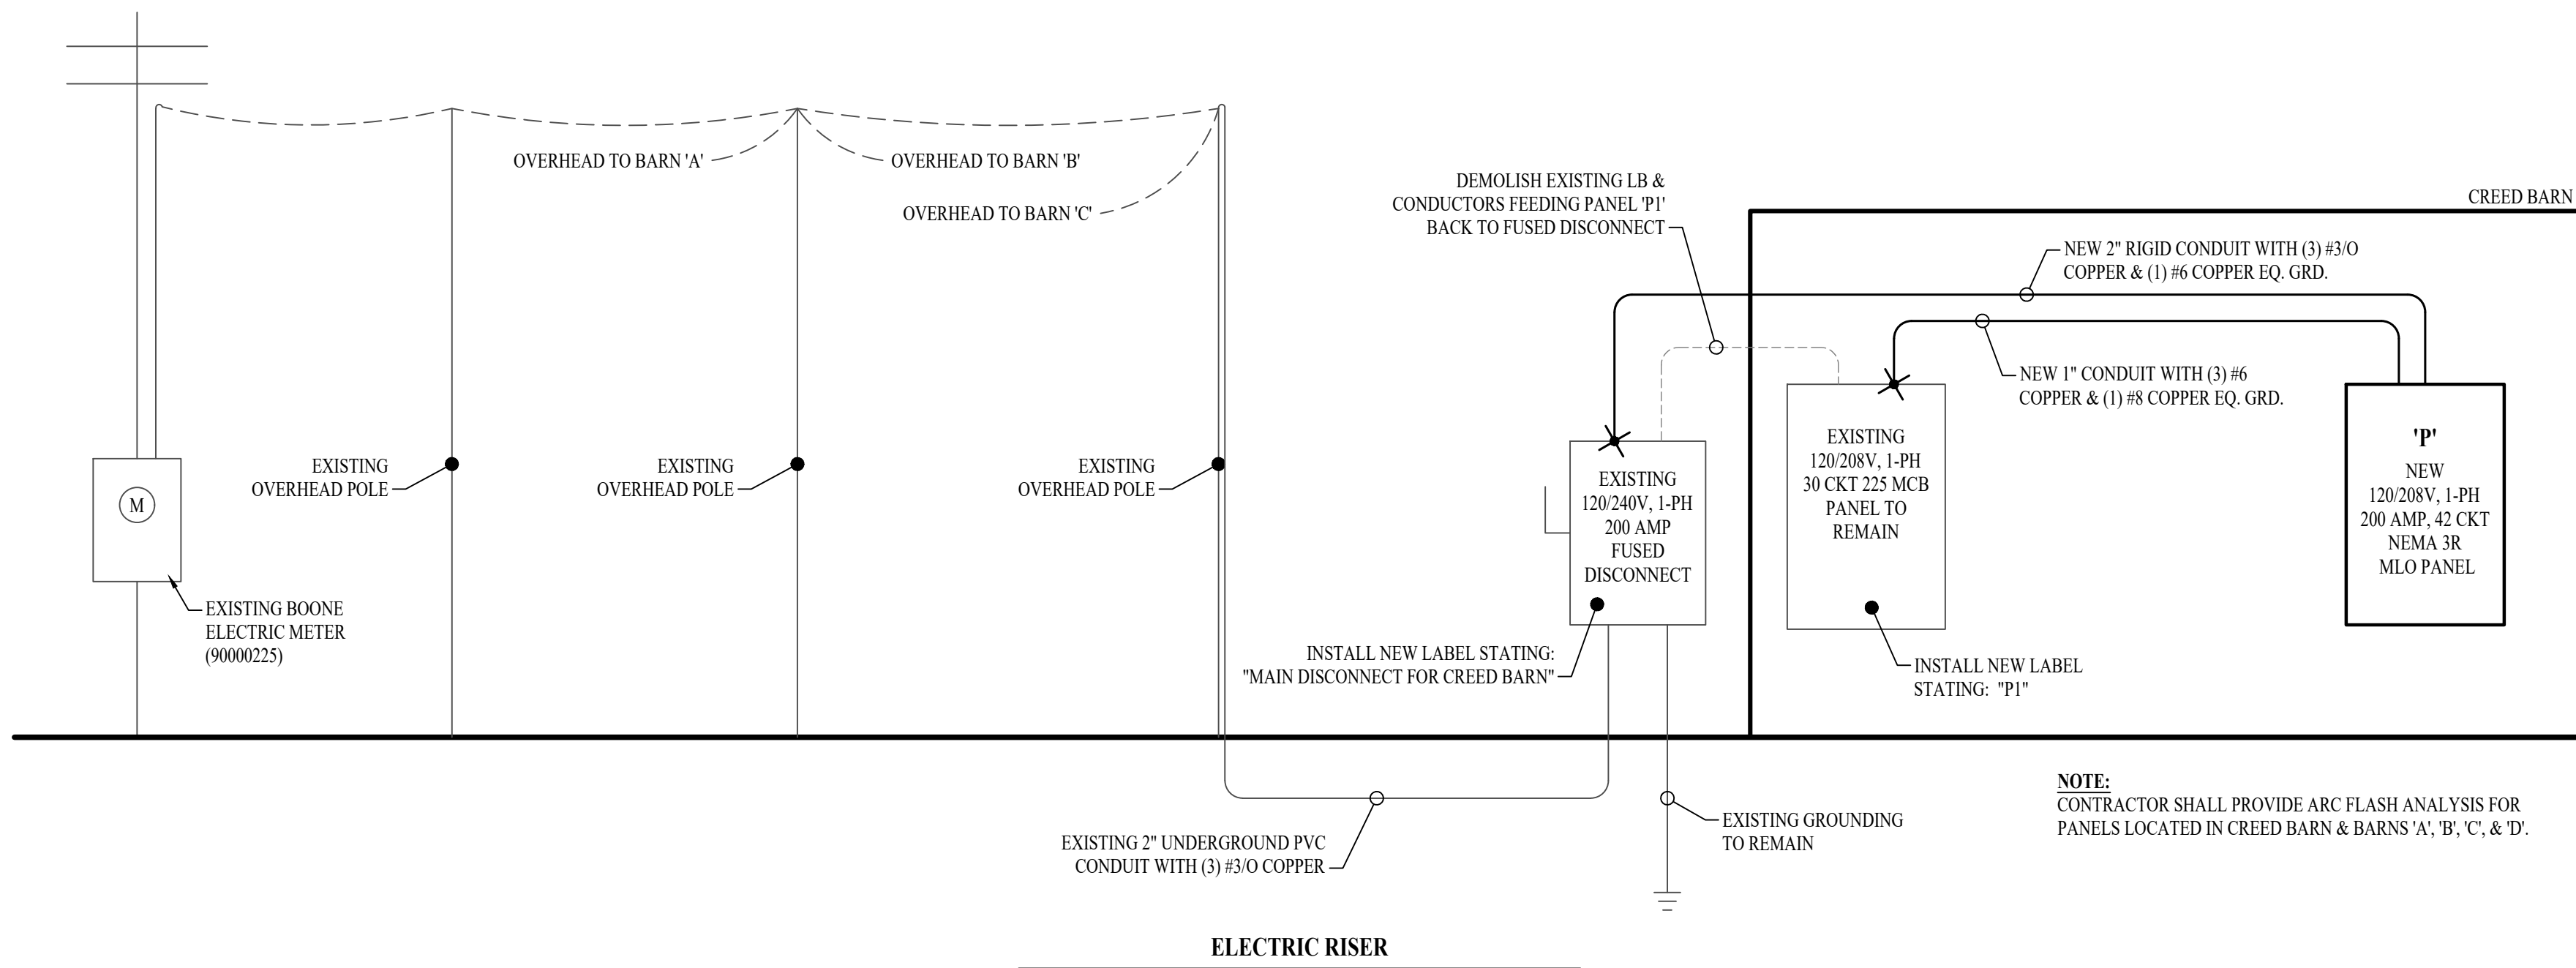


NOTE:
CONTRACTOR SHALL PROVIDE ARC FLASH ANALYSIS FOR PANELS LOCATED IN CREED BARN & BARNS 'A', 'B', 'C', & 'D'.

PANEL 'P' SCHEDULE									
VOLTAGE		PANEL SIZE		MOUNTING		ARC RATING		PHASE "A" LOAD	
120/208V		200 AMP MLO		SURFACE		22,000		139	
NEMA RATING: 3R								PHASE "B" LOAD	
								142.5	
CIRCUIT NUMBER	DESCRIPTION	BREAKER SIZE	AMPS	PHASE	AMPS	BREAKER SIZE	DESCRIPTION	CIRCUIT NUMBER	
1	CATTLE TREATMENT OUTLETS	20-1	6	A	1.5	20-1	CATTLE TREATMENT CORD REEL	2	
3	CATTLE TREATMENT CORD REEL	20-1	1.5	B	6	20-1	CATTLE TREATMENT & TV OUTLETS	4	
5	STORAGE COUNTER OUTLETS	20-1	4.5	A	7	20-1	REFRIGERATOR	6	
7	CATTLE STAGING CORD REEL	20-1	1.5	B	1.5	20-1	CATTLE STAGING CORD REEL	8	
9	SPARE	20-1	-	A	1.5	20-1	CATTLE STAGING CORD REEL	10	
11	CATTLE STAGING OUTLETS	20-1	4.5	B	7.5	20-1	SOUTH TUBE HEATER	12	
13	NORTH TUBE HEATER	20-1	7.5	A	25	50-2	CHUTE PUMP	14	
15	CONDENSING UNIT (CU-1)	20-2	12	B	25	-	-	16	
17	-	-	12	A	6.5	20-2	WATER HEATER (WH-1)	18	
19	AIR HANDLING UNIT (AHU-1)	25-2	24	B	6.5	-	-	20	
21	-	-	24	A	7	20-1	CATTLE TREATMENT LIGHTING	22	
23	EXHAUST FAN (EF-1)	20-2	12	B	7	20-1	CATTLE STAGING LIGHTING	24	
25	-	-	12	A	1	20-1	STORAGE LIGHTING	26	
27	PRESSURE WASHER	20-1	10	B	-	20-1	SPARE	28	
29	GARAGE DOOR OPENER	20-1	3.5	A	-	20-1	SPARE	30	
31	GARAGE DOOR OPENER	20-1	3.5	B	-	20-1	SPARE	32	
33	SPARE	20-1	-	A	-	-	-	34	
35	SPARE	20-1	-	B	-	-	-	36	
37	EXISTING PANEL 'P1'	50-2	20	A	-	-	-	38	
39	-	-	20	B	-	-	-	40	
41	-	-	-	A	-	-	-	42	


NOTES:
A: PANEL SHALL BE EQUAL TO SQUARE D MODEL "QO"
B: ELECTRICIAN SHALL VERIFY BREAKER WITH EQUIPMENT PRIOR TO PURCHASE & INSTALL.
C: AFTER COMPLETION OF WORK, ELECTRICIAN SHALL PROVIDE A TYPE WRITTEN PANEL DIRECTORY IN NEW PANEL.

AGRICULTURAL EQUIPOTENTIAL PLANE BONDING & GROUND GENERAL NOTES:


1. BUILDING SHALL BE PROVIDED WITH AN EQUIPOTENTIAL PLANE & ALL REQUIRED BONDING FOR ANIMAL CONFINEMENT AREAS WITHIN BUILDING. EQUIPOTENTIAL PLANE SHALL MEET ALL REQUIREMENTS AS DICTATED IN NEC ARTICLE 547.
2. EMBEDDED IN CONCRETE REINFORCING WIRE MESH NO SMALLER THAN #10 GAUGE FORMING A CONTINUOUS GRID. THE GRID COVERAGE SHALL ENCOMPASS ALL STRUCTURAL CONCRETE FOR THE NEW ADDITION. REFERENCE STRUCTURAL DRAWINGS / SPECIFICATIONS FOR ADDITIONAL INFORMATION.
3. SYSTEM OF REINFORCEMENT SHALL BE ELECTRICALLY CONTINUOUS. TWISTED STEEL TIE WIRE CONNECTING ALL WIRE MESH SHALL BE USED TO BOND ALL COMPONENTS OF THE GRID TOGETHER IN THE CONCRETE. THE WIRES SHALL BE MADE TIGHT & SHALL BE INSPECTED TO BE AS SUCH PRIOR TO CONCRETE POUR.
4. THE REINFORCING & STEEL TIE WIRE SHALL BE BY CONCRETE CONTRACTOR. THE WIRES SHALL ONLY BE USED TO BOND THE WIRE MESH TOGETHER & SHALL NOT BE USED TO BOND OTHER METAL COMPONENTS.
5. ELECTRICAL CONTRACTOR SHALL BOND ALL OTHER METAL COMPONENTS IN WHICH ANIMALS MAY COME IN CONTACT WITH, INCLUDING BUT NOT LIMITED TO, METALLIC PIPING, METAL GRATES, STALLS, GATES & ASSOCIATED SUPPORTS USING MINIMUM #8 SOLID COPPER CONDUCTOR BACK TO THE REINFORCING IN THE CONCRETE. BONDS SHALL BE BY PRESSURE CONNECTORS OR BRASS OR COPPER CLAMPS OR EQUALLY SUBSTANTIAL APPROVED METHOD. IT IS IMPORTANT THAT THE EQUIPOTENTIAL GROUNDING SYSTEM BE INSPECTED ONCE THESE BONDS ARE MADE, BUT BEFORE THE CONCRETE IS POURED.
6. ALL METAL COMPONENTS IN THE BUILDING THAT THE ANIMAL COULD COME IN CONTACT WITH INCLUDING THE REINFORCING IN THE CONCRETE SLAB SHALL BE ELECTRICALLY CONTINUOUS & CONNECTED BACK TO THE ELECTRICAL SERVICE GROUNDING ELECTRODE SYSTEM. A PIECE OF STRUCTURAL REBAR SHALL BE EXPOSED UP THROUGH THE SLAB AT THE ELECTRICAL SERVICE ENTRANCE FOR BONDING BETWEEN EQUIPOTENTIAL PLANE SYSTEM & BUILDING GROUNDING ELECTRODE SYSTEM AT SERVICE ENTRANCE. THE EXACT LOCATION IN WHICH REBAR IS TO BE STUBBED UP SHALL BE FULLY COORDINATED BETWEEN ELECTRICAL CONTRACTOR & CONCRETE CONTRACTOR.

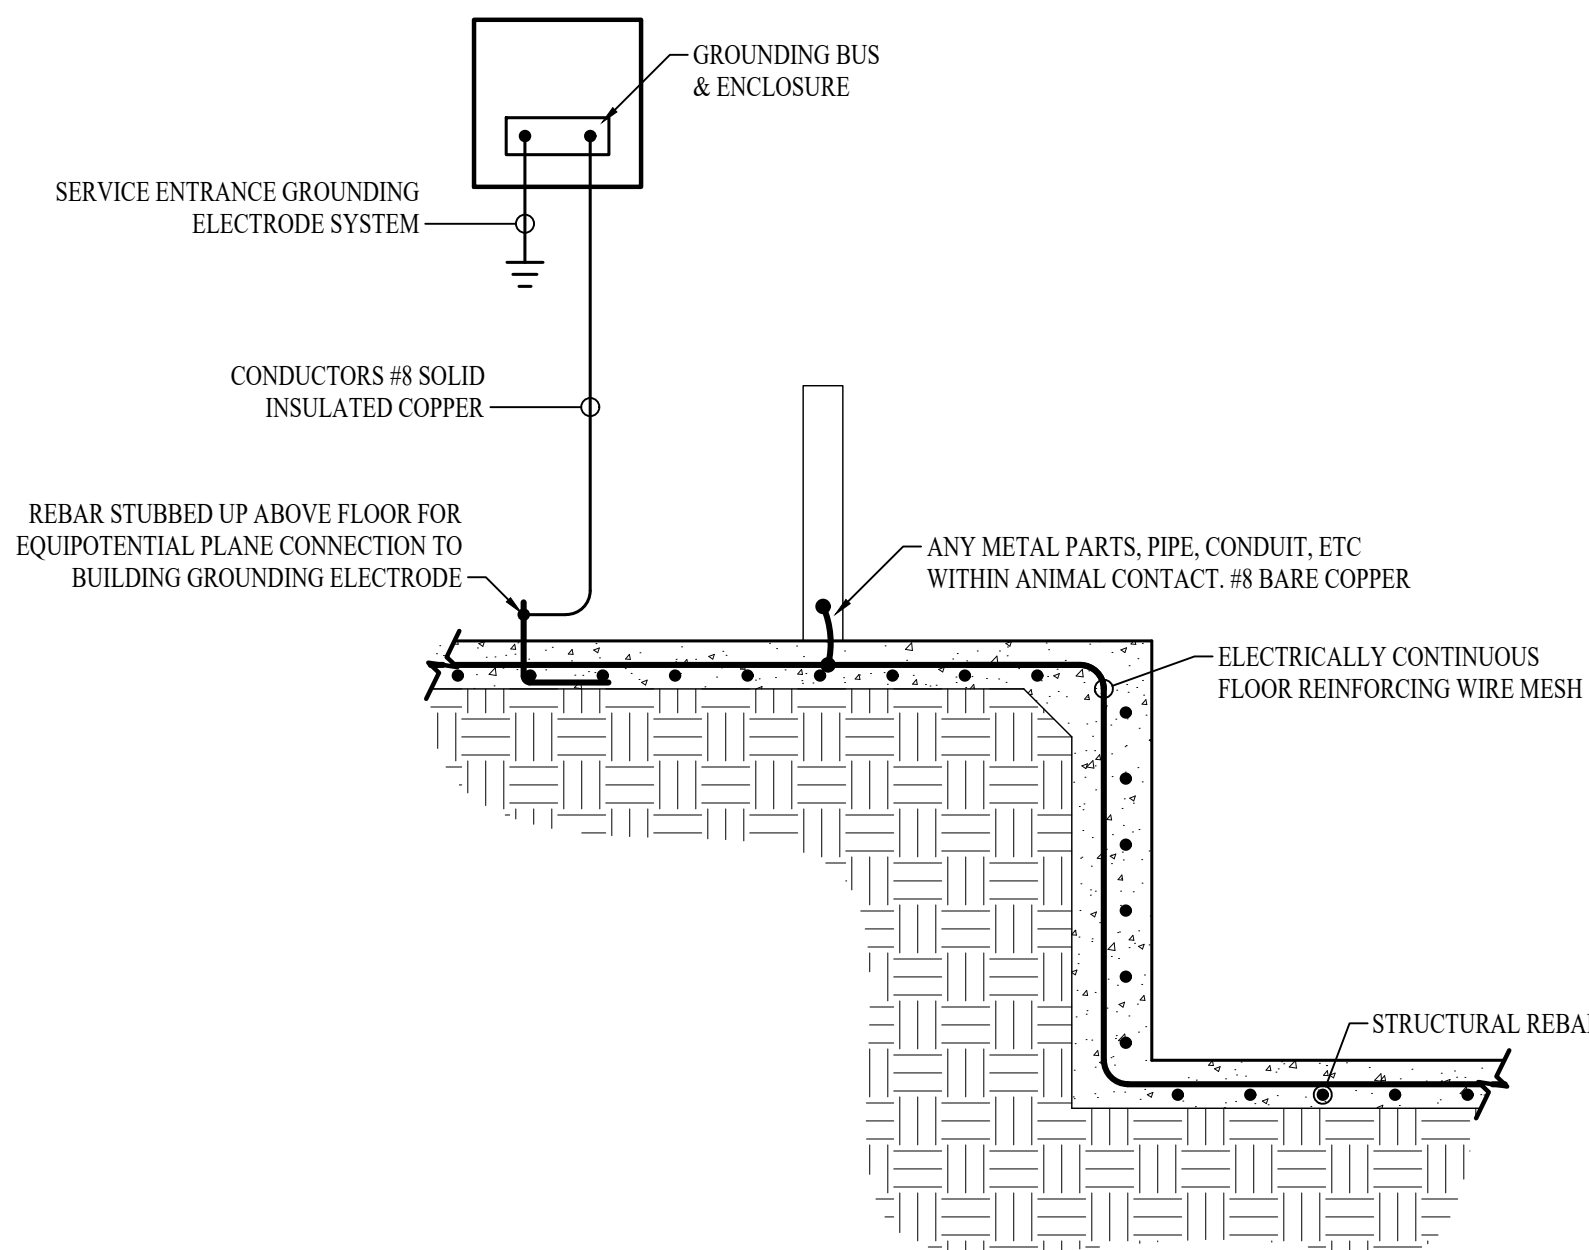

AGRICULTURAL EQUIPOTENTIAL PLANE GROUNDING DETAIL

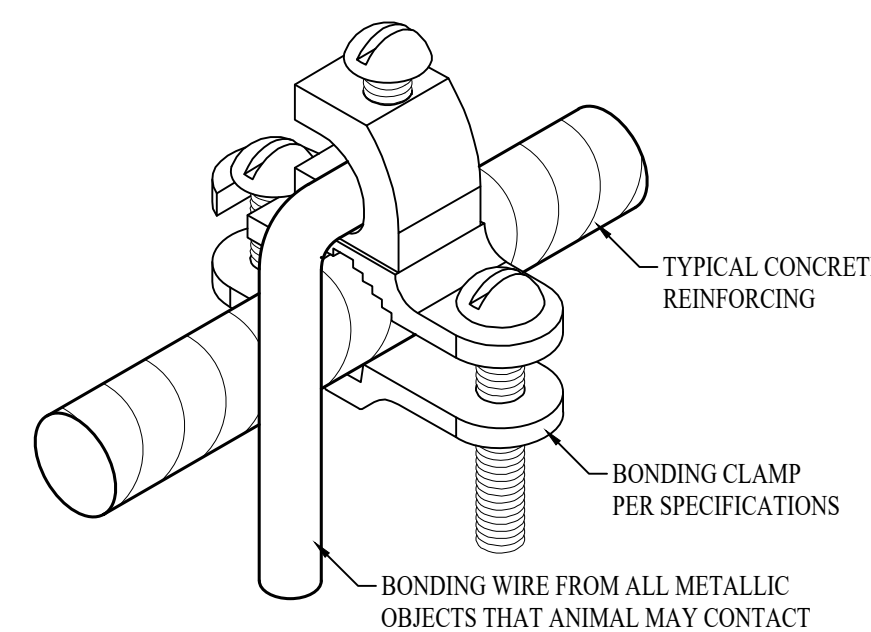


REBAR BONDING CLAMP DETAIL

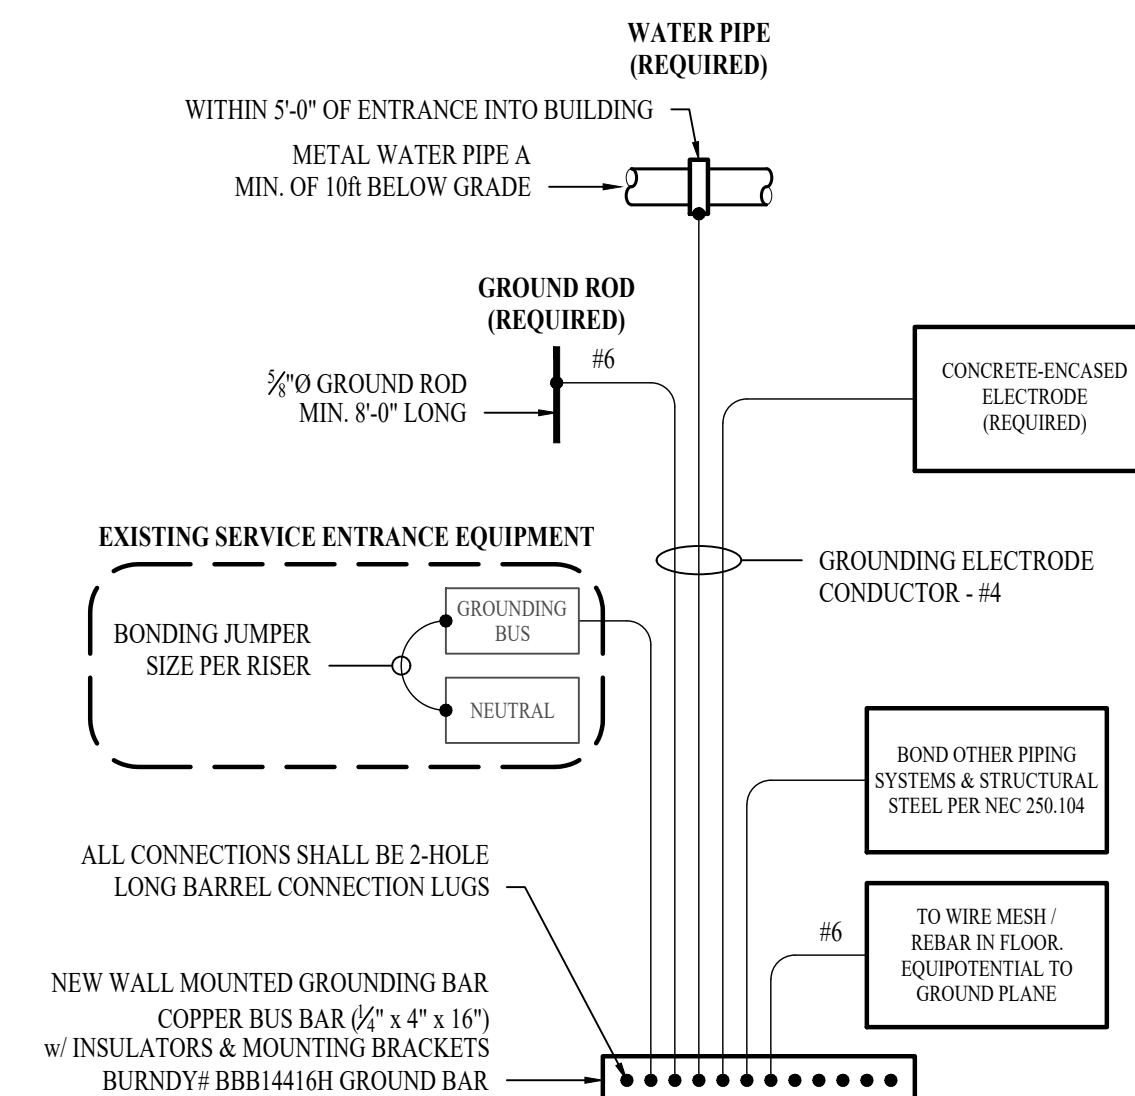

TYPICAL GROUNDING & BONDING DETAIL



James Watson, P.E. March 26, 2024
PE-2015017071
MO Certificate of Authority # 2018029680

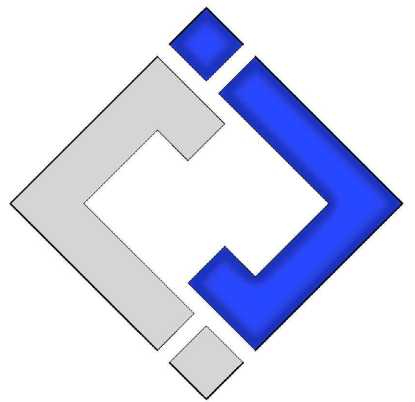

J-SQUARED ENGINEERING

2400 Bluff Creek Drive, Suite 101
Columbia, Missouri 65201
573 - 234 - 4492 phone
www.j-squaredeng.com

J2 PROJECT No: J21143

J2 DESIGN: JAP

ISSUE TITLE DATE

DD SET 01 - 19 - 2024

100% CD 02 - 09 - 2024

BID SET 03 - 01 - 2024

ADDENDUM #1 03 - 26 - 2024

CP241191 South Farm Creed Barn Remodel
 Mechanical - Electrical - Plumbing Design Drawings for
 5151 Old Millers Road
 Columbia, Boone County, MO 65201

AHU APPROVAL STAMP

SHEET TITLE

ELECTRICAL DETAILS & SCHEDULES

SHEET NUMBER

E501

PLUMBING SPECIFICATIONS








1. GENERAL
 - 1.1. PLUMBING CONTRACTOR IS RESPONSIBLE TO PROVIDE ALL ESCUTCHEONS, 1/2 TURN STOPS, P-TRAPS, AND SUPPLY LINES TO PROVIDE A COMPLETE SYSTEM AT EACH FIXTURE INDICATED ON PLANS UNLESS NOTED OTHERWISE.
2. SANITARY
 - 2.1. BELOW AND ABOVE GRADE WASTE AND VENT PIPING IN BUILDING TO BE SOLID CORE SCH. 40 PVC DWV.
 - 2.2. NO PIPE SMALLER THAN 2" BELOW GRADE.
 - 2.3. WASTE AND VENT PIPING IN PLENUMS TO BE CAST IRON.
 - 2.4. ALL VENT PIPE TERMINATIONS ARE TO BE LOCATED EITHER 10' HORIZONTALLY OR 3' ABOVE MECHANICAL AIR INTAKE LOCATIONS.
3. DOMESTIC WATER
 - 3.1. DOMESTIC WATER PIPING TO BE COPPER.
 - 3.2. COPPER WATER PIPING BELOW GRADE SHALL BE CTS POLY. THERE SHALL BE NO JOINTS IN WATER PIPING LOCATED BENEATH BUILDING SLAB.
 - 3.3. COPPER WATER PIPING ABOVE GRADE SHALL BE TYPE "L".
 - 3.4. PROVIDE WATER HAMMER ARRESTORS AT ALL QUICK-CLOSE VALVES. FIXTURES REQUIRING WATER HAMMER ARRESTORS INCLUDE BUT ARE NOT LIMITED TO FLUSH VALVES, SENSOR FAUCETS, AND WASHING MACHINE BOXES. AIR CHAMBERS ARE NOT ACCEPTABLE.
 - 3.5. DOMESTIC WATER PIPING INSULATION
 - 3.5.1. ALL HW PIPING SHALL BE INSULATED WITH PLENUM RATED CLOSED CELL ELASTOMERIC INSULATION. FOR PIPING LESS THAN 1/2", INSULATION THICKNESS TO BE 1". FOR PIPING 1/2" OR GREATER, INSULATION THICKNESS SHALL BE 1/2".
 - 3.5.2. CW COPPER PIPING TO INSULATED WITH 1/2" PLENUM RATED CLOSED CELL ELASTOMERIC INSULATION.

PLUMBING FIXTURE SCHEDULE				
TAG	DESCRIPTION	MANUFACTURER (OR EQUAL)	MODEL (OR EQUAL)	NOTES
FCO	FLOOR CLEAN OUT	ZURN	Z1400	
FD	FLOOR DRAIN	ZURN	Z415-BZ	WITH Z1072 TRAP SEAL
MS	MOP SINK	FIAT	MSB2424	WITH ZURN Z84M1 FAUCET WITH WALL HOOK
SK	SINGLE COMPARTMENT SINK (22x19x7)	ELKAY	LR2219	WITH TWO HANDLED ZURN Z871C4-XL FAUCET
WH1	WATER HEATER	RUUD	EGSP20	20 GALLON, 240V, 1500W
YCO	YARD CLEAN OUT	ZURN	Z1400	


NOTES:
1. VERIFY NECESSARY FIXTURES MEET ADA REQUIREMENTS WITH ARCHITECT PRIOR TO INSTALLATION

PLUMBING CONNECTION SIZING SCHEDULE						
FIXTURE	TYPE	TYPICAL ABBREVIATION	SANITARY PIPING		SUPPLY PIPING	
			WASTE CONNECTION	VENT CONNECTION	COLD WATER CONNECTION	HOT WATER CONNECTION
DRINKING FOUNTAIN	DF	DF	1-1/2"	1-1/4"	1/2"	-
FLOOR DRAIN	FD	FD	3"	2"	-	-
HAND / HAIR SINK	HS / SK	HS / SK	2"	1-1/4"	1/2"	1/2"
HOSE BIBB	HB	HB	-	-	3/4"	-
LAVATORY	LAV	LAV	1-1/2"	1-1/4"	1/2"	1/2"
MOP SINK	MS	MS	3"	1-1/2"	1/2"	1/2"
ICE MAKER OUTLET BOX	REF	REF	-	-	1/2"	-
SHOWER	SH	SH	3"	1-1/2"	1/2"	1/2"
URINAL	UR	UR	2"	1-1/4"	3/4"	-
WATER CLOSET (FLUSH TANK)	WC	WC	3"	2"	1/2"	-
WATER CLOSET (FLUSH VALVE)	WC	WC	3"	2"	1"	-

NOTES:
1. SIZES SHOWN ABOVE ARE TYPICAL UNLESS NOTED OTHERWISE ON PLANS

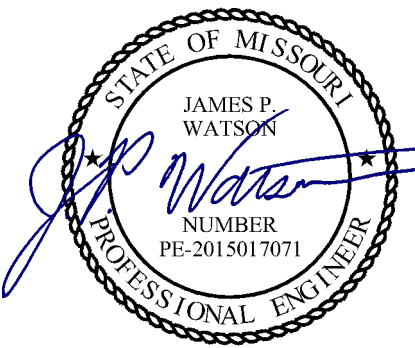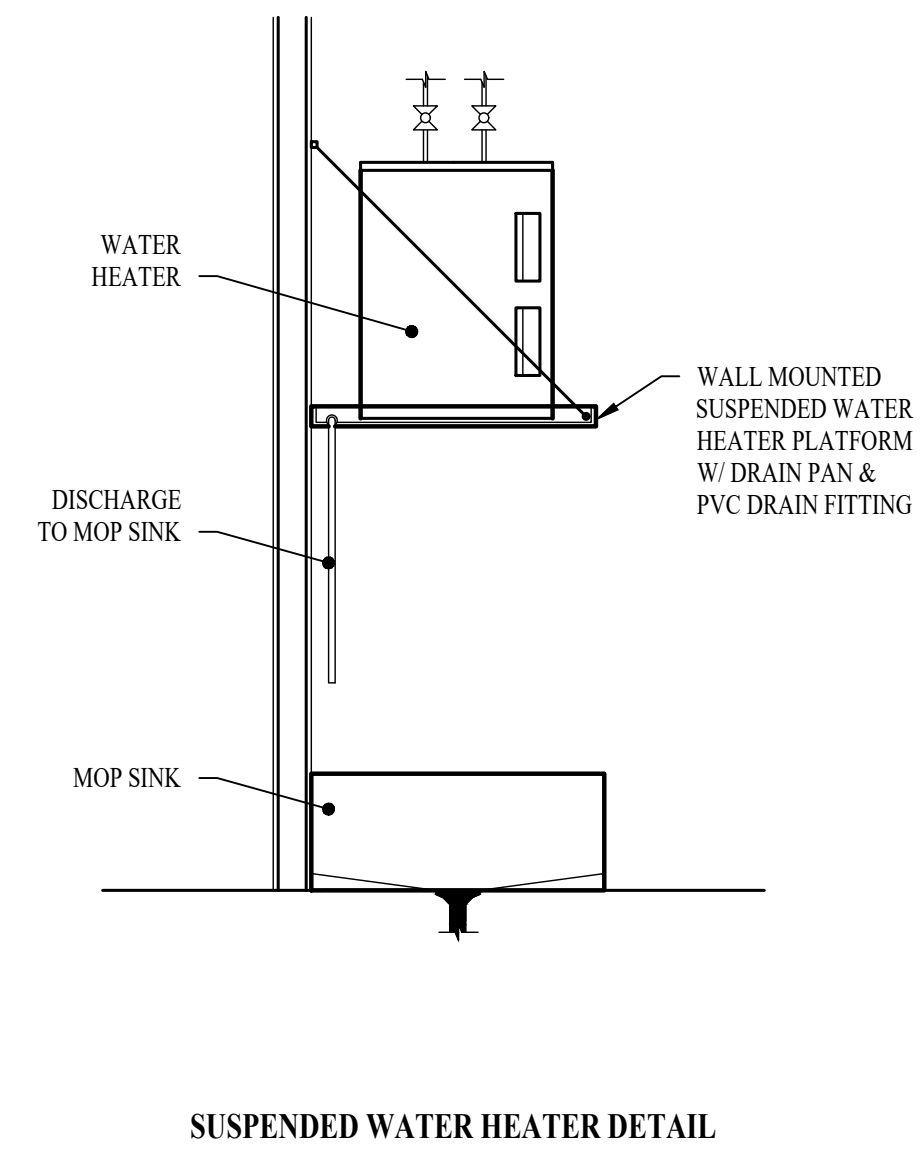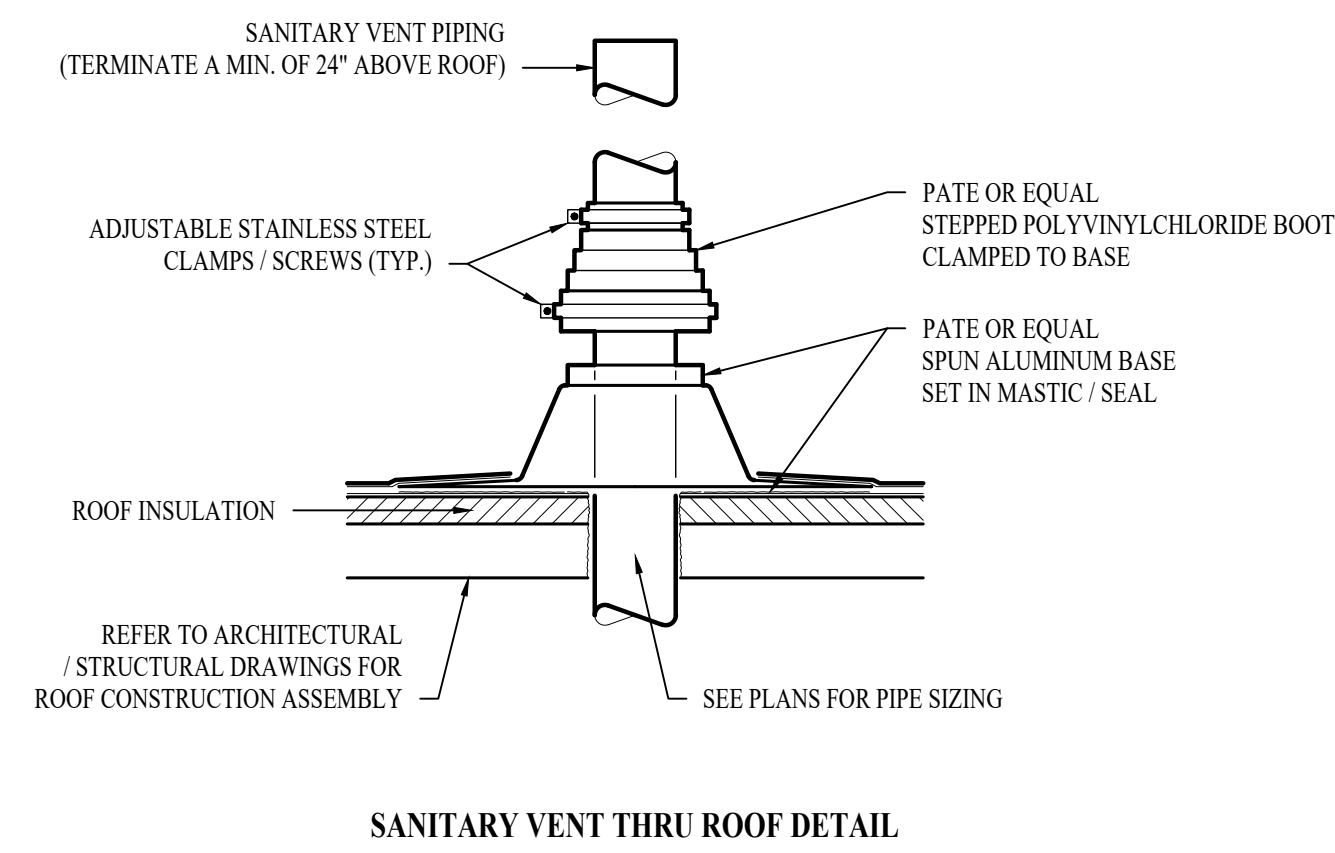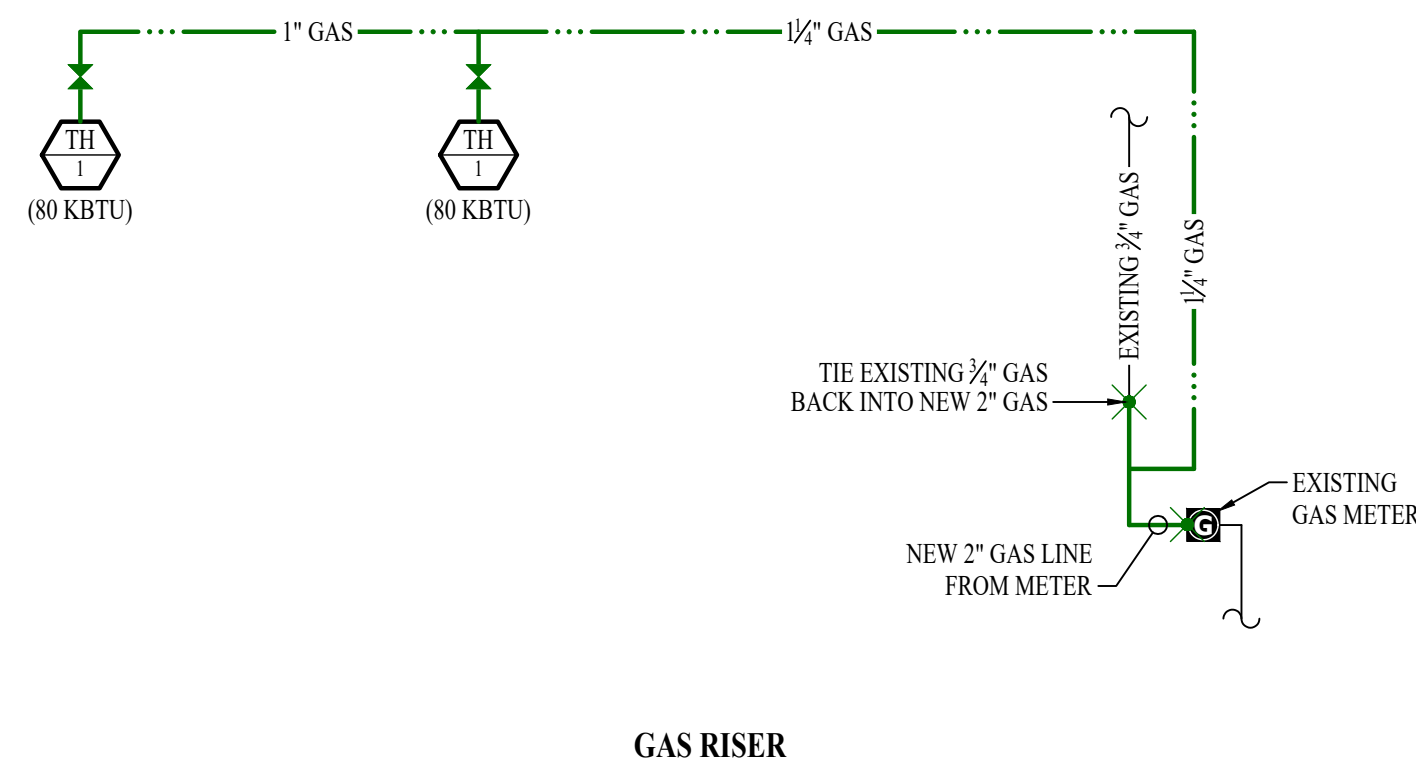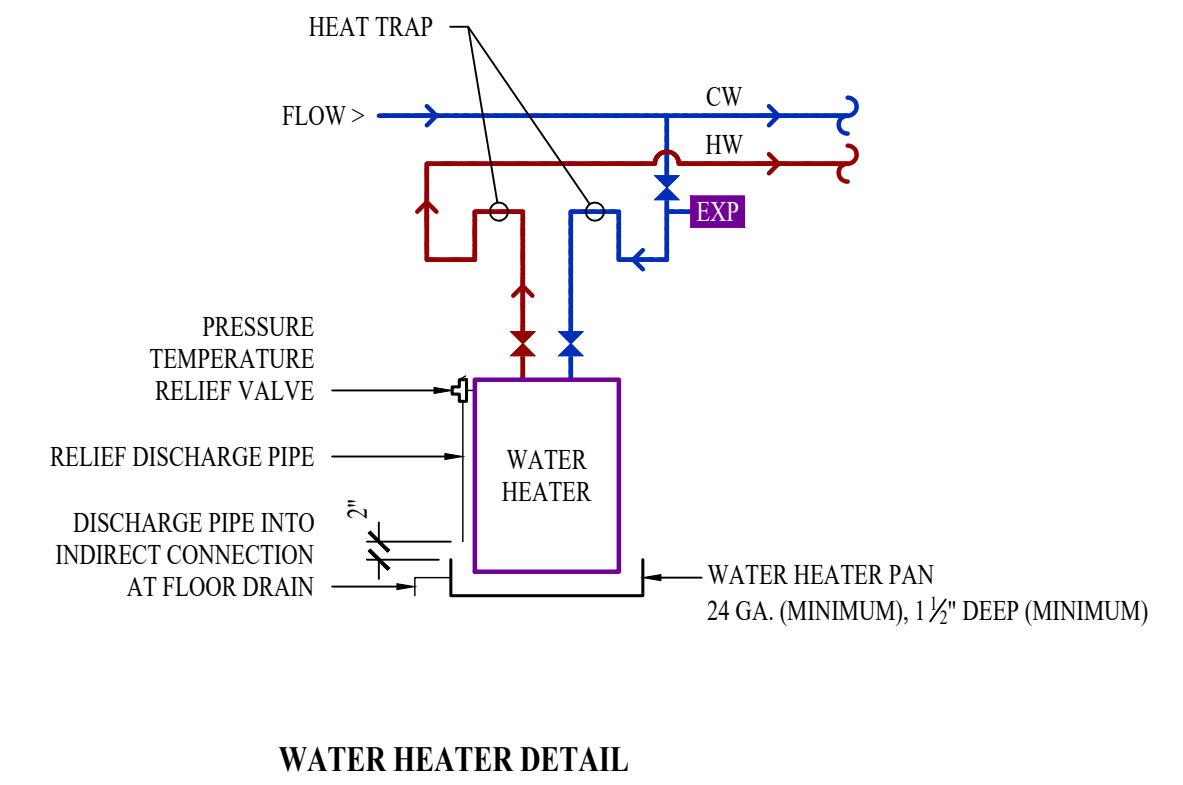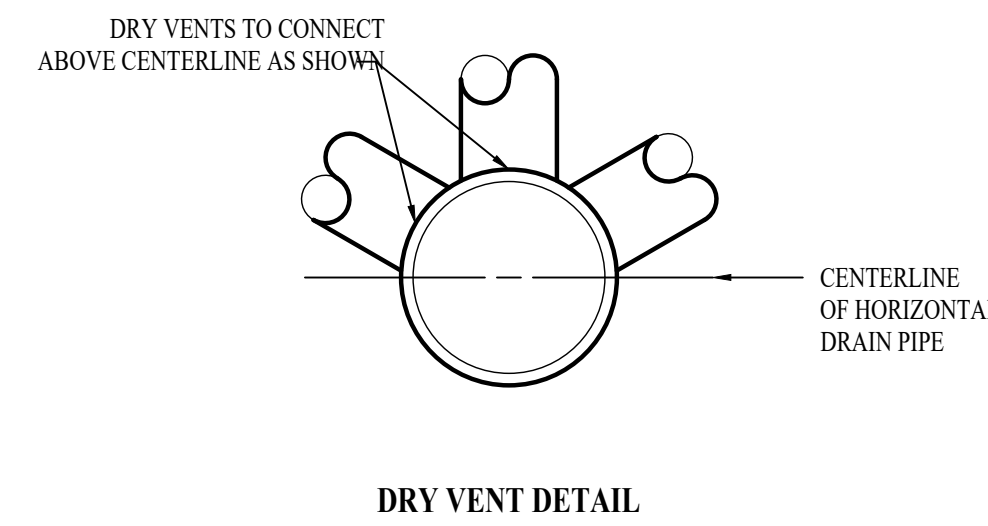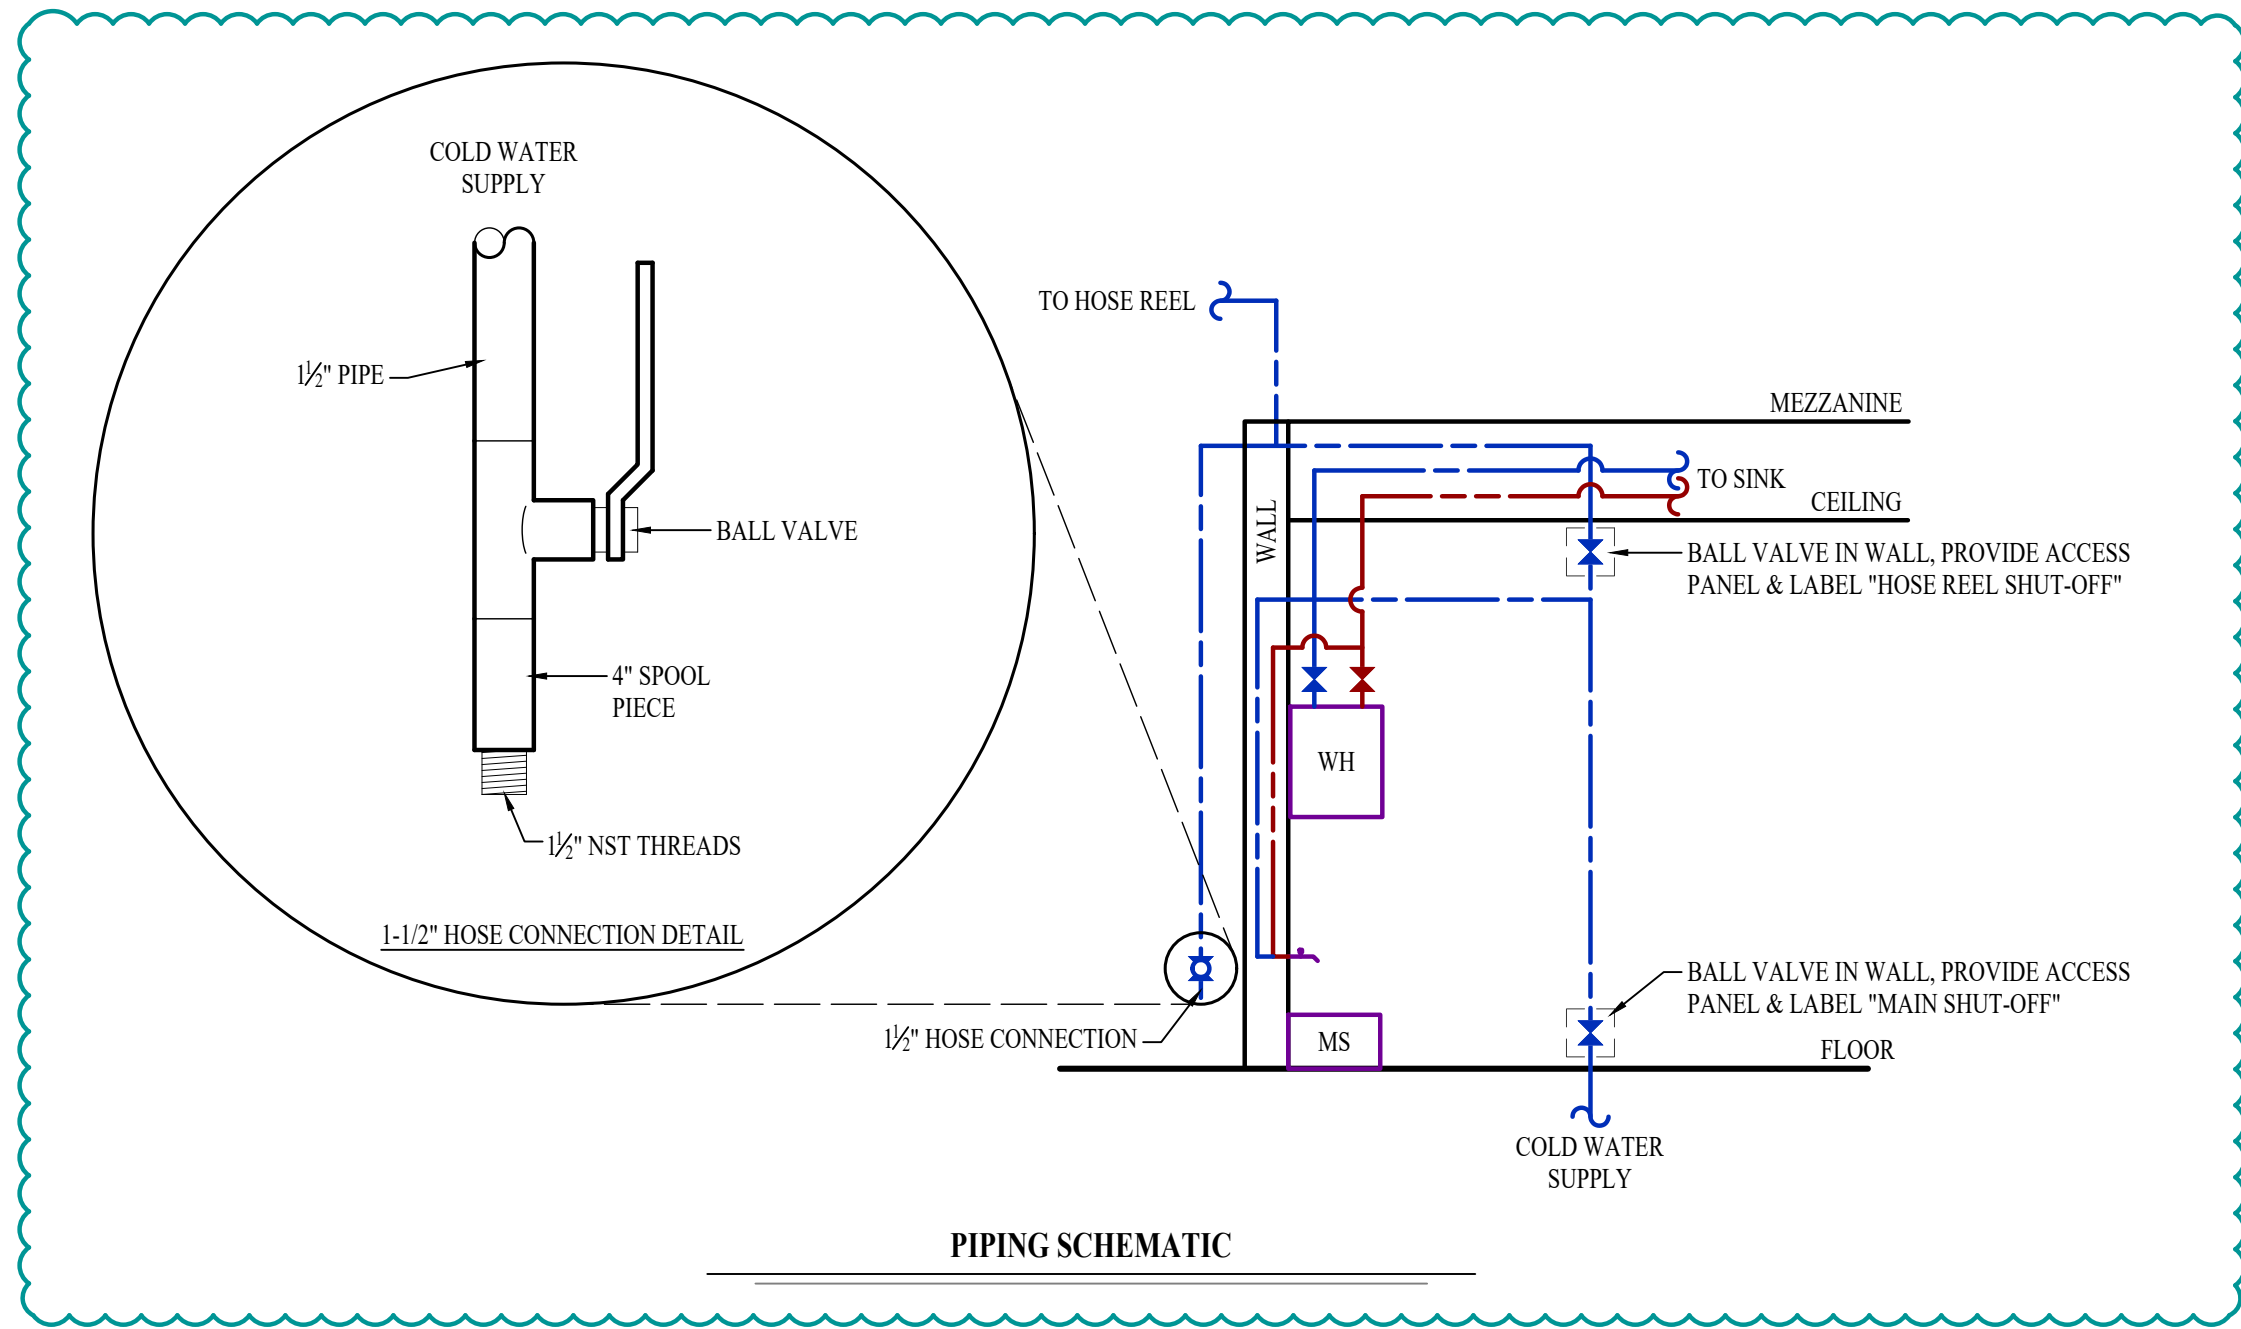

James Watson, P.E. March 26, 2024
PE-2015017071
MO Certificate of Authority # 2018029680

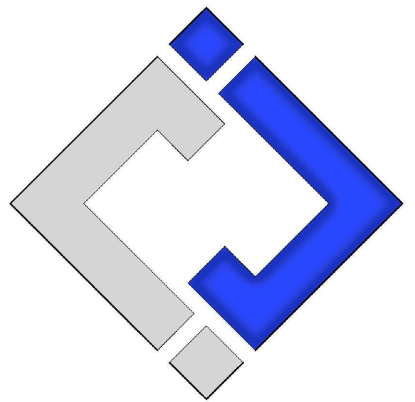

J-SQUARED ENGINEERING
2400 Bluff Creek Drive, Suite 101
Columbia, Missouri 65201
573 - 234 - 4492 phone
www.j-squaredeng.com

J2 PROJECT No: J21143
J2 DESIGN: JAP

ISSUE TITLE	DATE
DD SET	01 - 19 - 2024
100% CD	02 - 09 - 2024
BID SET	03 - 01 - 2024
ADDENDUM #1	03 - 26 - 2024

Mechanical - Electrical - Plumbing Design Drawings for
CP241191 South Farm Creed Barn Remodel
5151 Old Millers Road
Columbia, Boone County, MO 65201

AHJ APPROVAL STAMP

SHEET TITLE

PLUMBING DETAILS & SCHEDULES

SHEET NUMBER
P501